


## CONSTRUCTION NOTES

- BUILDING POWER PANEL LOCATION.
- EC SHALL PROVIDE SECONDARY CONDUCTORS AND CONDUITS FROM TRANSFORMER TO BUILDING SERVICE LOCATION. COORDINATE EXACT REQUIREMENTS WITH UTILITY COMPANY.
- COORDINATE PYLON SIGN LOCATION WITH SIGN VENDER PRIOR TO TRENCHING, LOCATION SHOWN FOR PROVIDING POWER ONLY.
- SITE POLE LIGHTS, REFER TO CIVIL PLAN FOR POLE LIGHT SPECIFICATION AND PHOTOMETRIC STUDY.
- 2" CONDUIT FOR TELEPHONE SERVICE. CONTRACTOR SHALL SEE FINAL CIVIL DRAWINGS AND COORDINATE WITH THE UTILITY FOR FINAL TELEPHONE SERVICE LOCATION. SERVICE POINT WAS NOT KNOWN AT TIME OF PUBLICATION.
- (3) 1" CONDUITS UNDERGROUND TO MENU BOARD AND SPEAKER POST AT EACH LOCATION. SEE ARCHITECTURAL AND CIVIL SHEETS FOR MORE INFORMATION. COORDINATE WITH DT MENUBOARD INSTALLER FOR EXACT REQUIREMENTS PRIOR TO ROUGH-INS.

## GENERAL SITE PLAN NOTES

- CONDUIT RUNS ARE DIAGRAMMATICAL; CONTRACTOR TO RUN CONDUIT ALONG "PATH OF LEAST RESISTANCE". NO EXTRA FEES WILL BE PAID FOR ROCK BUSTING, UNLESS LL'S/TENANT'S REPRESENTATIVE AGREES THERE IS NO OTHER PATH AVAILABLE.

12.23.2022

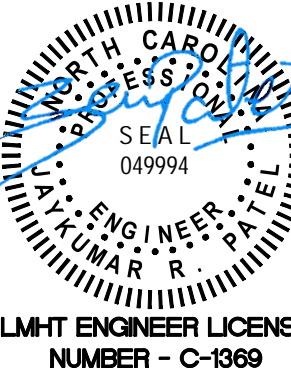

LMHT ENGINEER LICENSE  
NUMBER - C-1369

PROJECT: **HIGHWAY 55**  
30 PROTOTYPE  
1424 CURTIS BRIDGE ROAD  
WILKESBORO, NC 28697  
DRAWING: **ELECTRICAL SITE PLAN**

## Revisions

THRU ADDENDUM "A"  
01/20/2022

△ SITE PLAN UPDATE-12.23.2022


PROJECT DATE  
01/07/2022

Drawn By  
JP

Checked By  
JP


Sheet No.

**ES111**

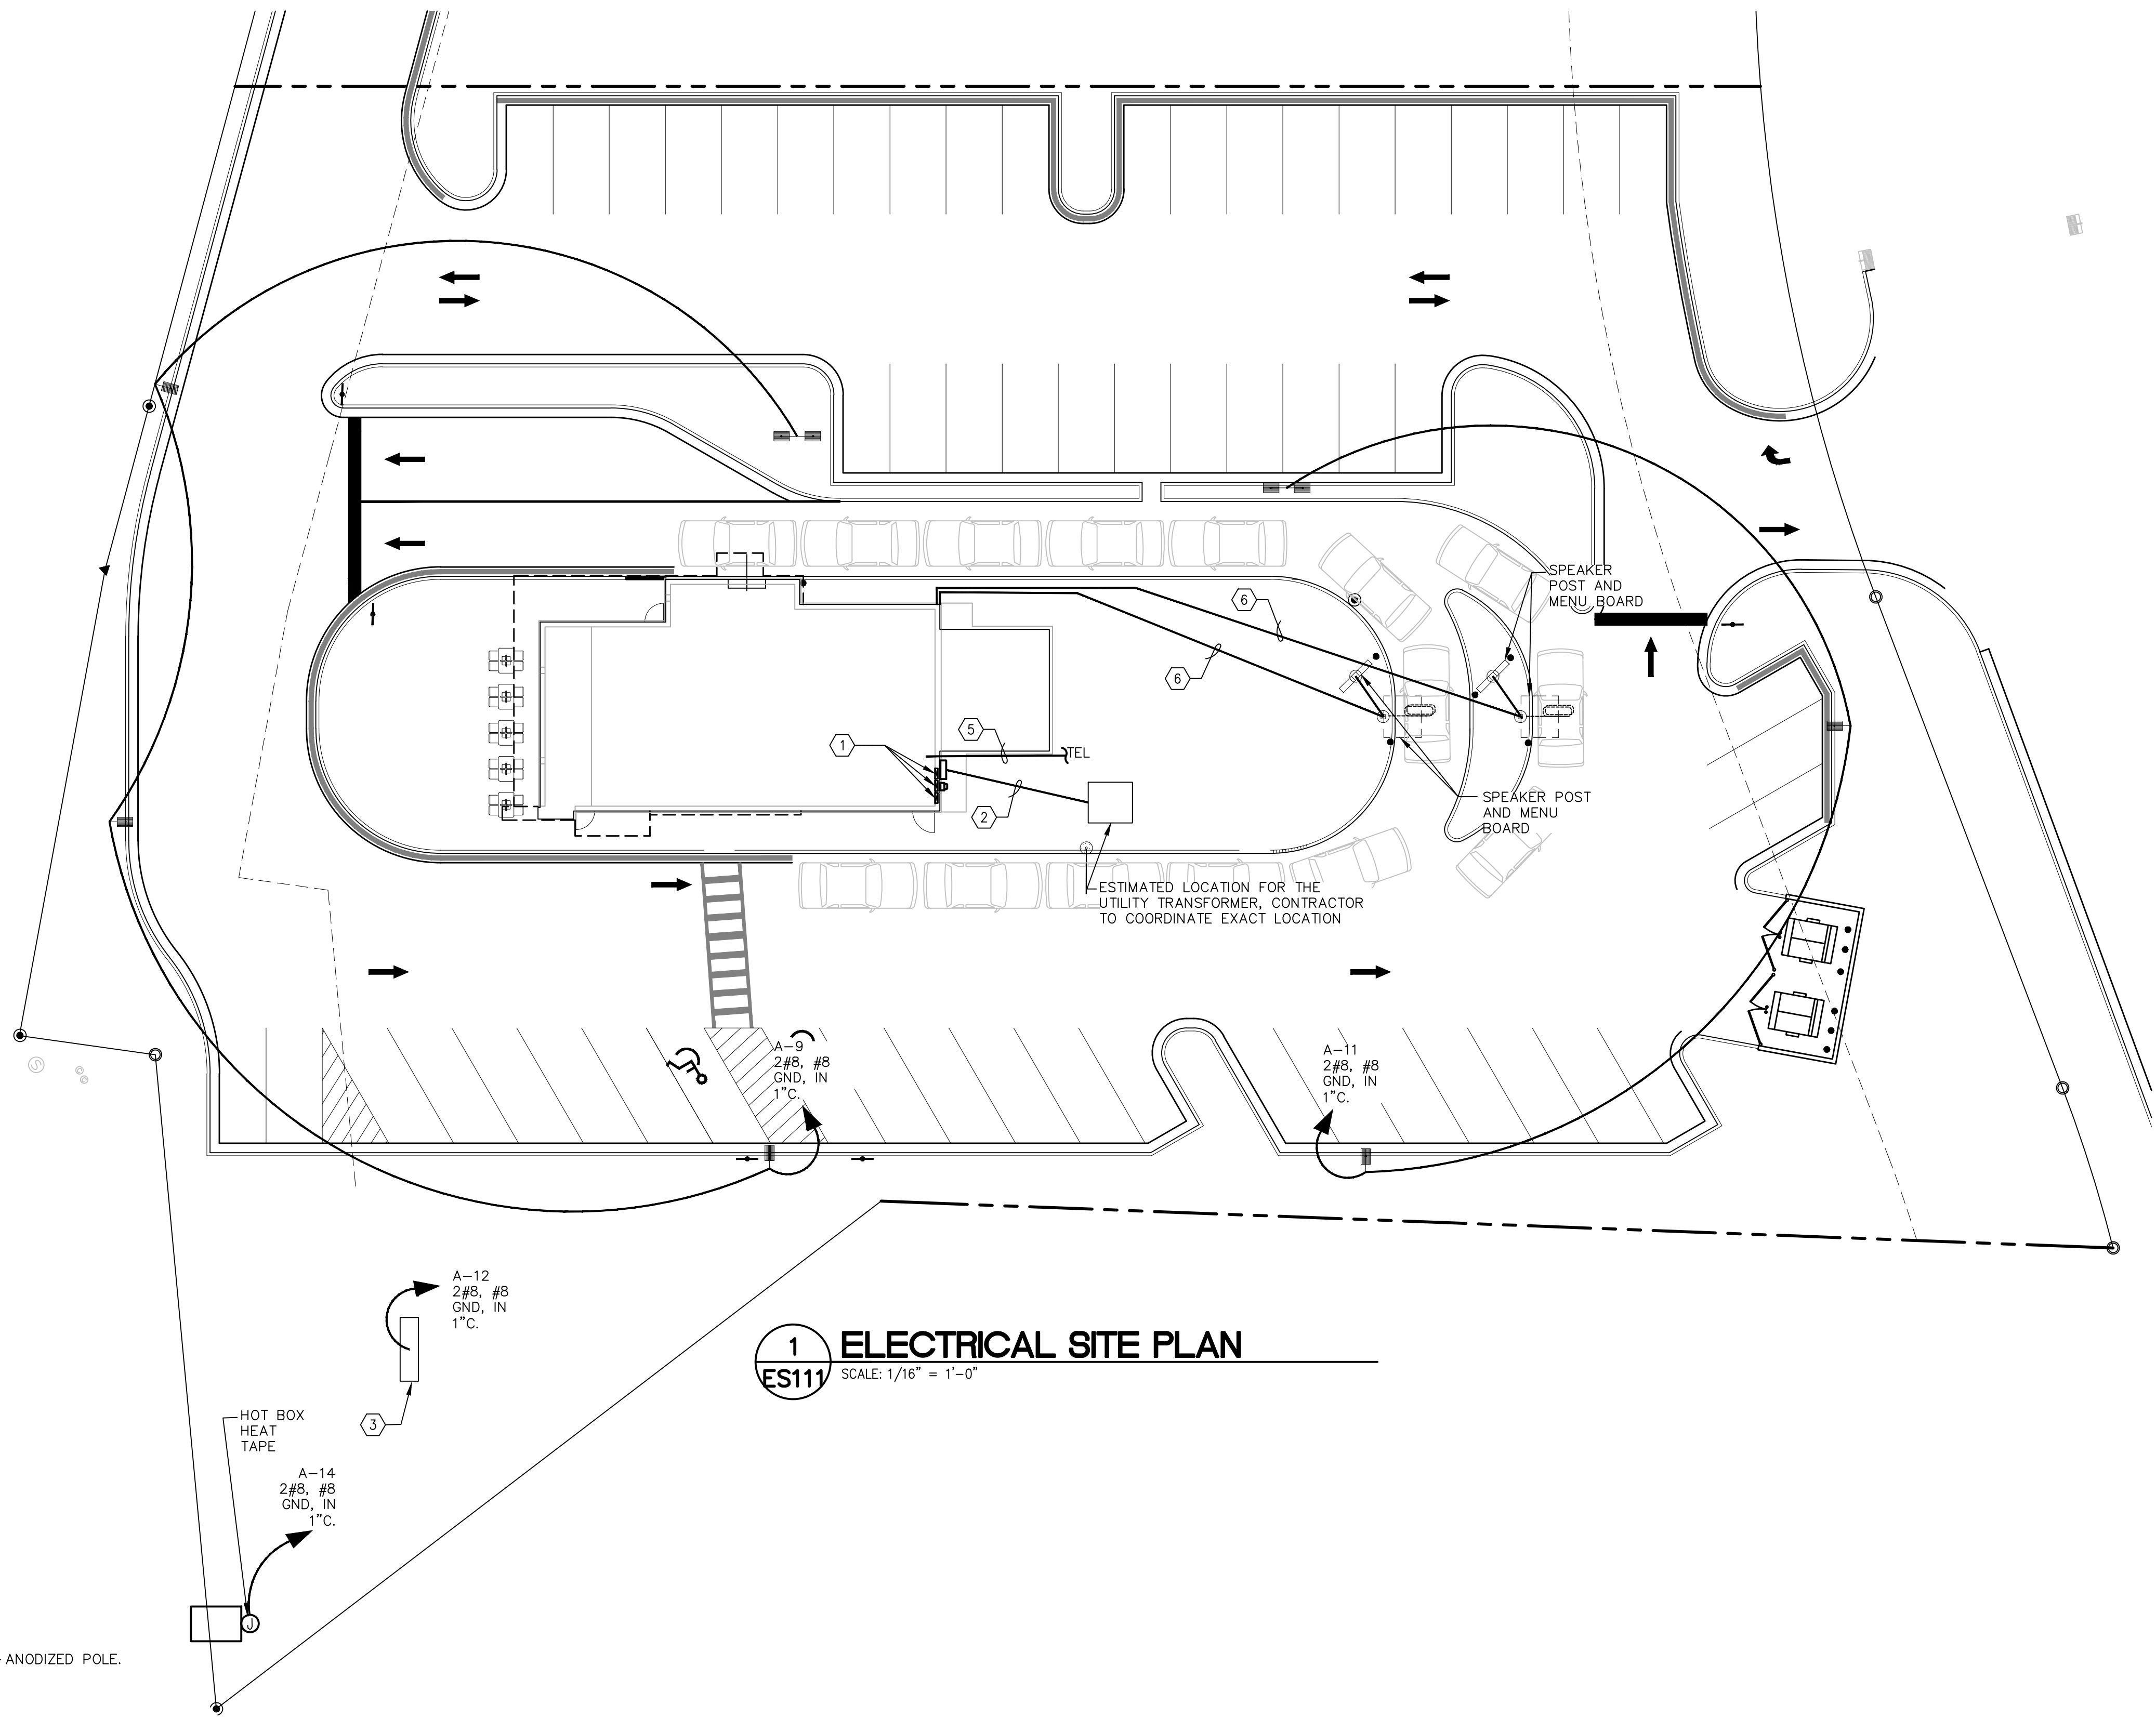

## 1 ELECTRICAL SITE PLAN

SCALE: 1/16" = 1'-0"

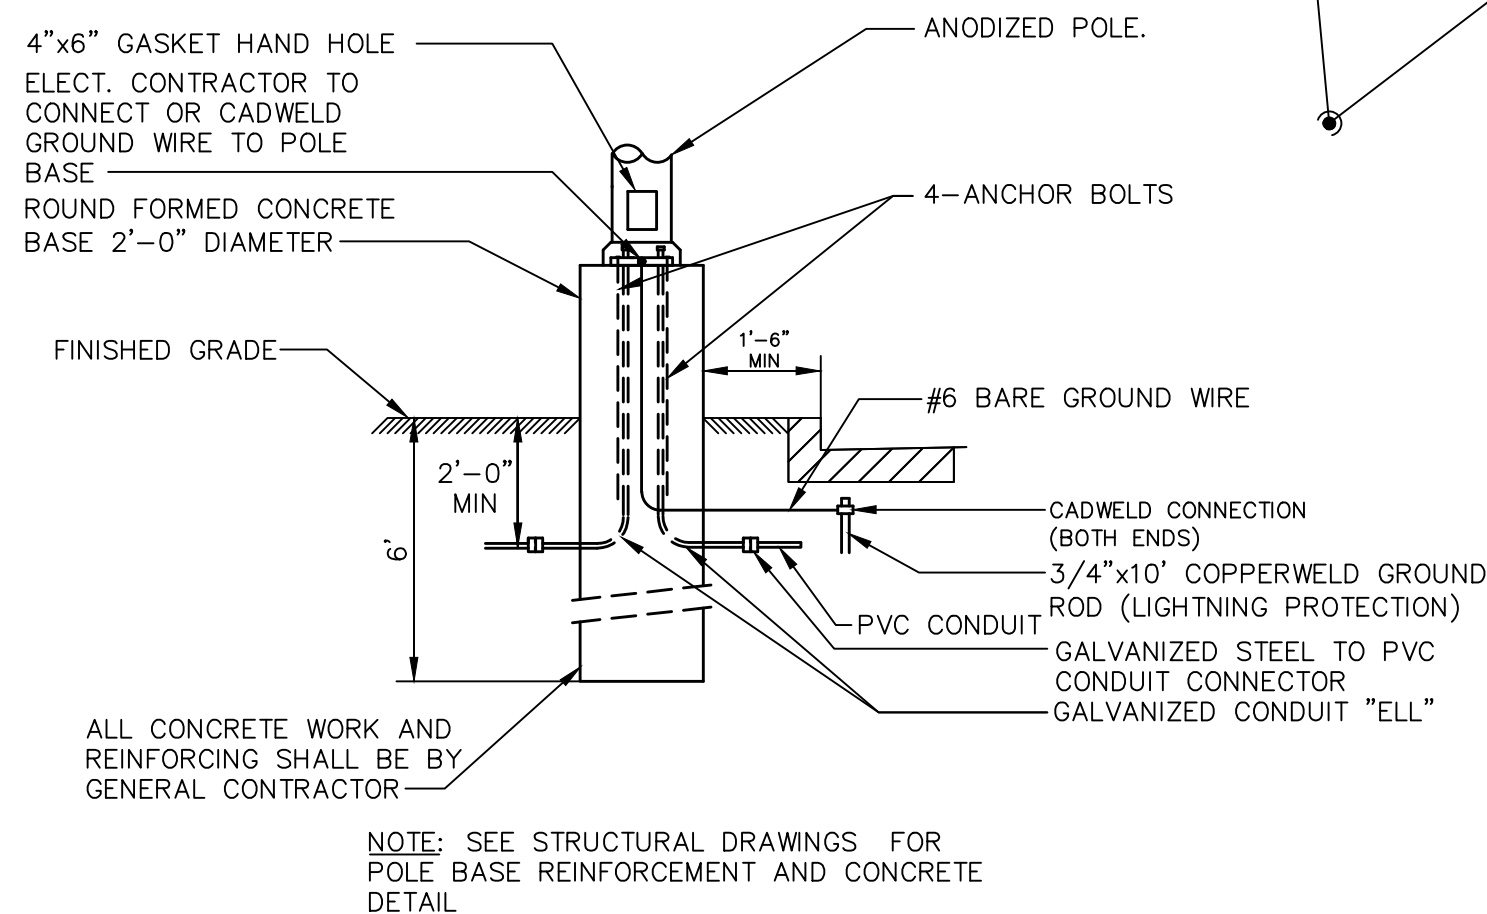

## 2 LIGHTING CONCRETE POLE BASE

SCALE: NOT TO SCALE